


SCALE 1" = 30' H
SCALE 1" = 10' V

1. ISOLATION VALVE BOX WILL ALSO BE USED AS A TRACER WIRE STATION.

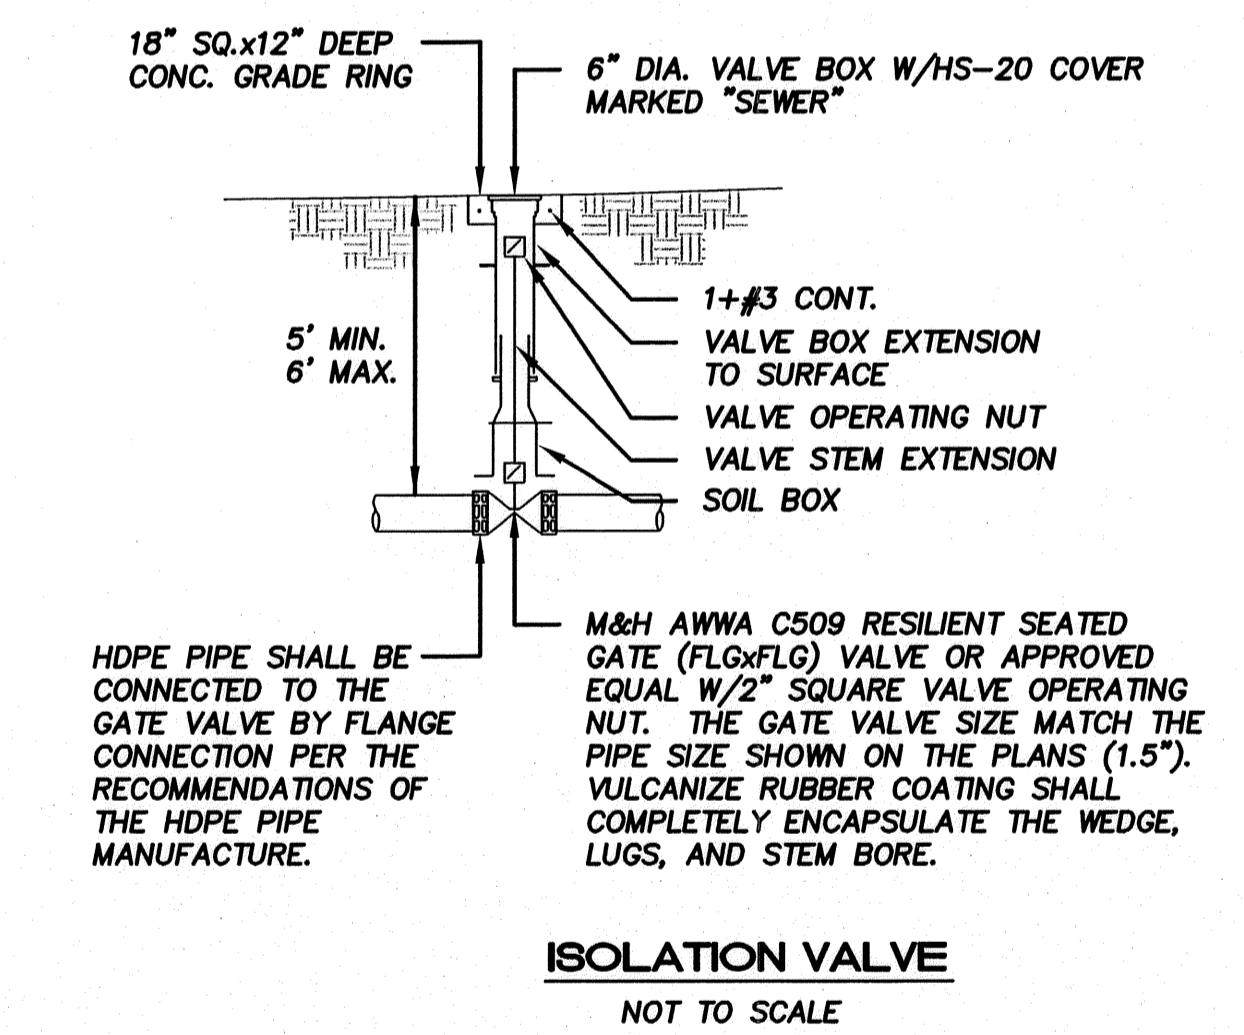

ISOLATION VALVE
NOT TO SCALE


GENERAL NOTES

1. CONSTRUCTION SHALL BE IN ACCORDANCE WITH COAL CREEK UTILITY DISTRICT STANDARD SPECIFICATIONS.
2. WHERE THE WATER MAIN CROSSES OVER SANITARY SEWER, THE MINIMUM VERTICAL SEPARATION SHALL BE 18 INCHES, OR CONSTRUCTION SHALL BE IN ACCORDANCE WITH D.O.E. CRITERIA FOR SEWAGE WORKS DESIGN (SEE DETAILS).
3. ALL SIDE SEWER TEES SHALL BE FIELD LOCATED
4. SECURE SIDE SEWER PERMITS FROM DISTRICT PRIOR TO INSTALLING SIDE SEWERS.
5. MANHOLE RING COVERS SHALL BE SLOPED TO MATCH THE GRADE OF THE STREET IN WHICH THEY ARE PLACED.
6. STREETS SHALL BE CONSTRUCTED TO SUBGRADE PRIOR TO INSTALLING THE SANITARY SEWERS.
7. SIDE SEWERS TO BE EXTENDED 10 FEET INTO THE LOTS.

CALL BEFORE YOU DIG

Call: TOLL FREE

1-800-424-5555

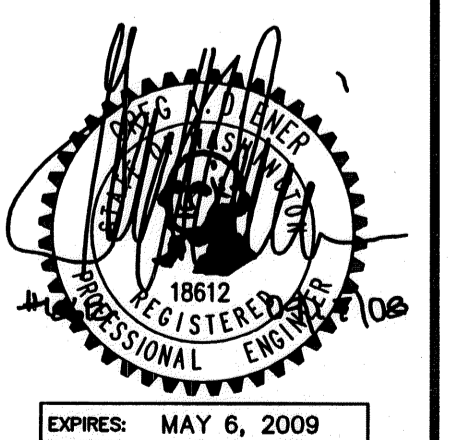

FILE NAME (UPDATED BY) PLOT DATE & TIME

DESIGNED				
DRAWN	JRL	REVISED PER COAL CREEK UTILITY DISTRICT COMMENTS	09/17/08	JGC DGS
CHECKED	DGS	ADD FORCE MAIN/PRESENT TWO OPTIONS	08/21/08	JGC DGS
	SYM	REVISION		DATE BY APP'D

Pacific Engineering Design, LLC

15445 53RD AVE. S. SEATTLE, WA 98188
PHONE: (206) 431-7970 FAX: (206) 388-1648 WEB SITE: PACENG.COM
Civil Engineering and Planning Consultants

COAL CREEK UTILITY DISTRICT

6801 132ND PLACE S.E.
NEWCASTLE, WASHINGTON 98059

REFERENCE INFORMATION	DATE
FIELD BOOK:	JULY 26, 2007
SURV. CPU FILE:	SCALE
DATUM: NGVD29	NOTED

VARNEY SEWER EXTENSION SANITARY SEWER MAIN ON-SITE PLAN AND PROFILE OPTION #1

JOB NUMBER	07020.00
DWG NO.	06015SS.DWG
SHEET	2 of 7